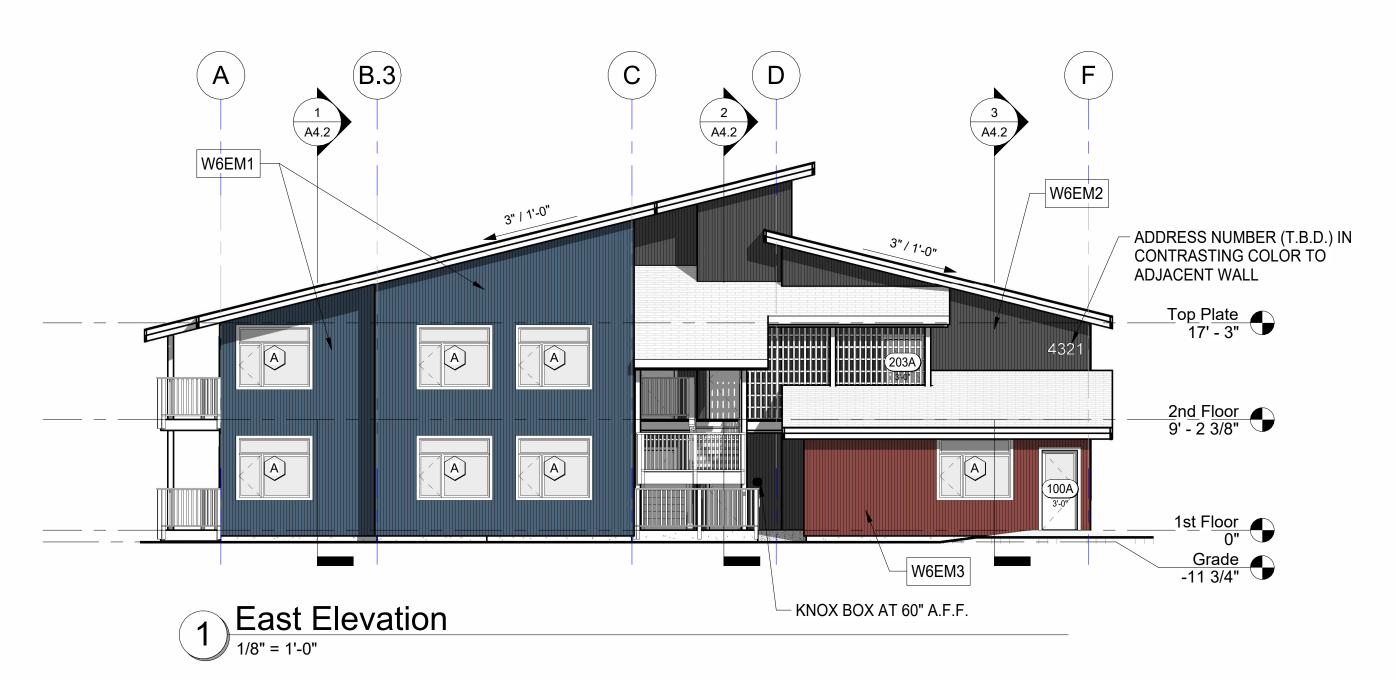
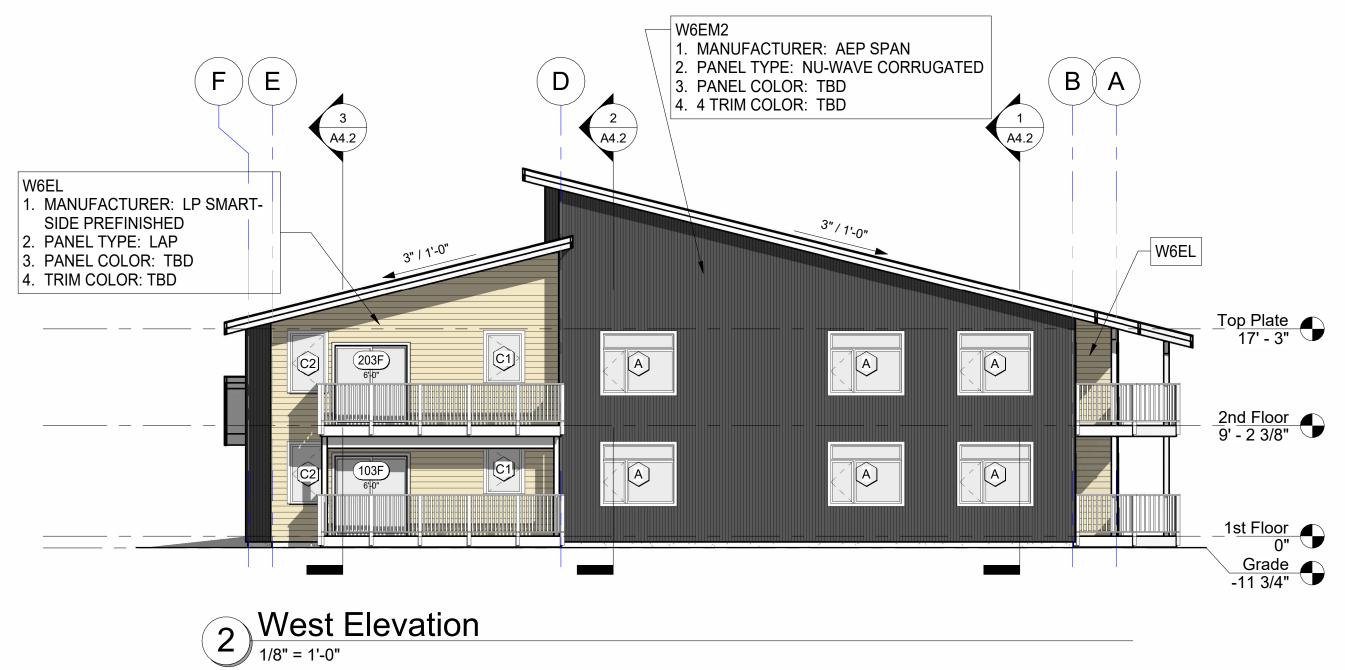
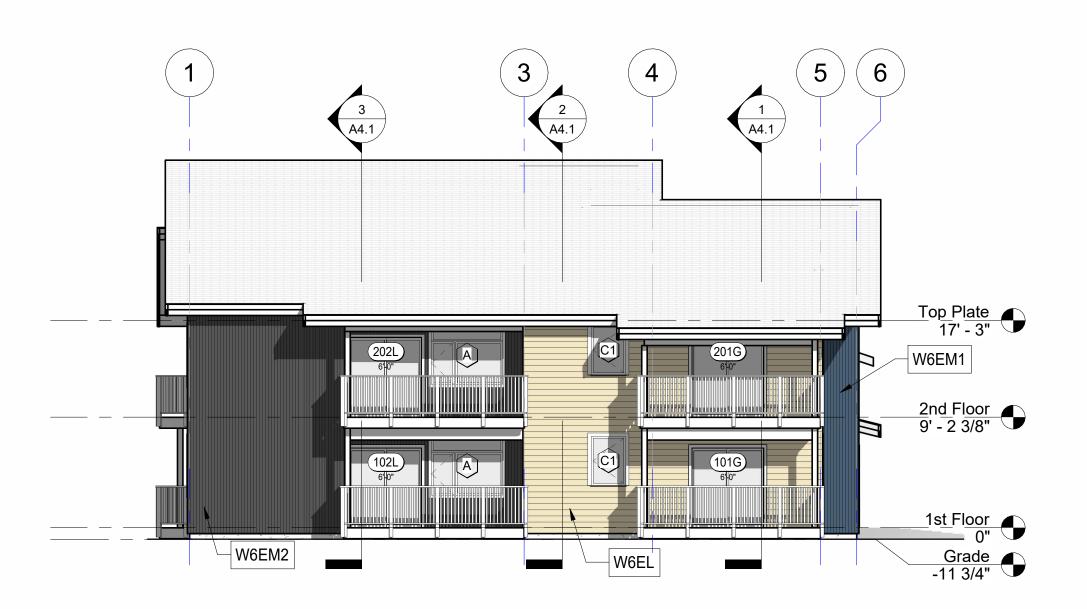
ATTACHMENT B. BAXTER FAMILY HOUSING PHASE I – VERTICAL CONSTRUCTION







South Elevation

1/8" = 1'-0"





FNA Project #: **2024_60A** Project Start Date: 11-06-2024

Release Date: 03-27-2025 Released for: Issued for Bid/ Permit/ Construction

04-15-2025 Exterior Finished Noted

Agth

Agth

Thomas D. Faulkenberry

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PROFESSIONA

IHA - Baxter Residential Development

ase 1 - Multi-Family - 6 Plex

JILDING A

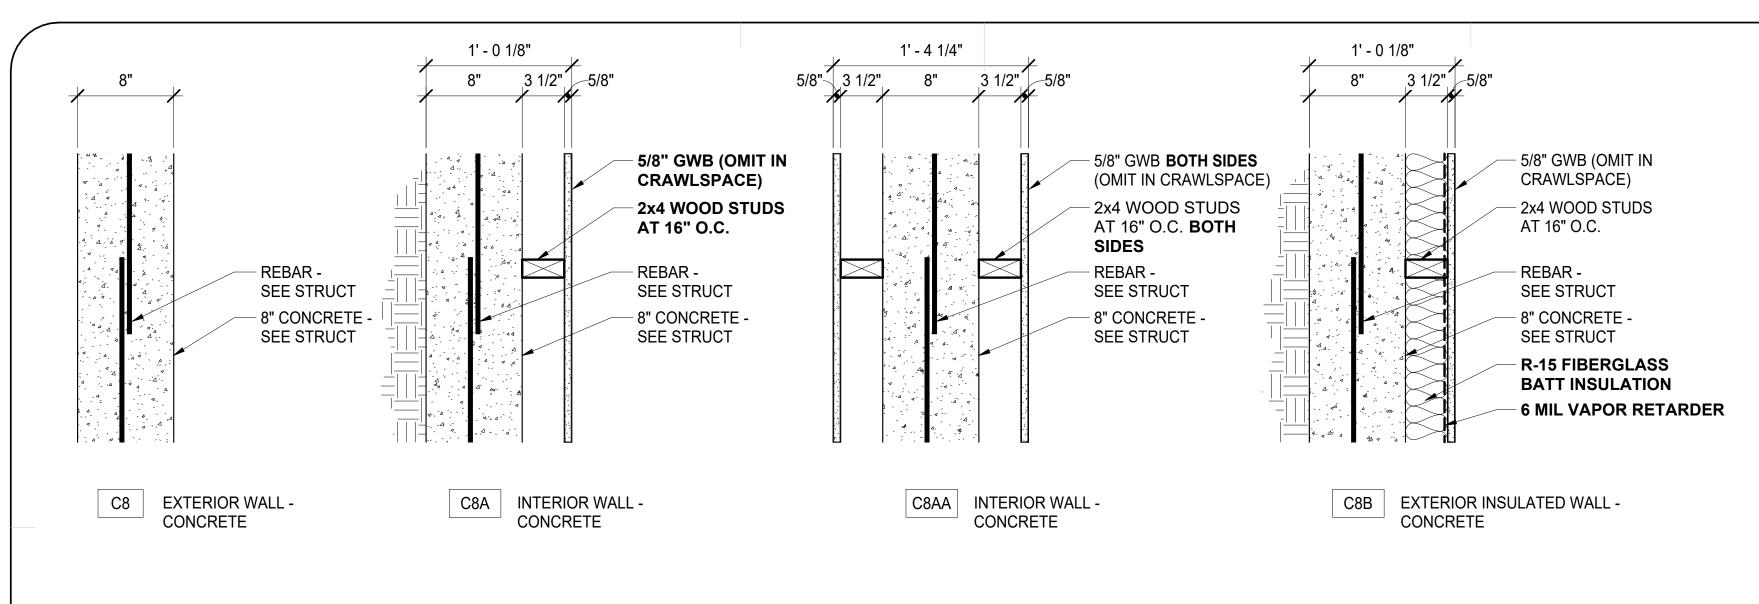
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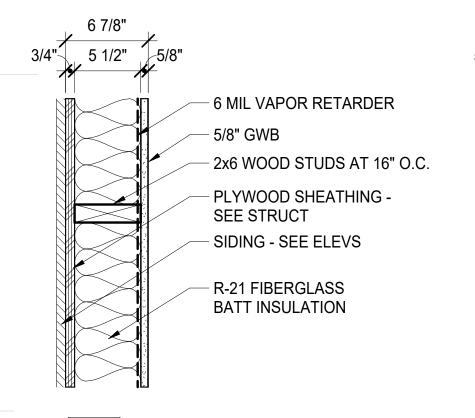
etskaya Addition # 1Subdivision

20 Baxter Road

20 Baxter Road

Sheet name Exterior Elevations





W6E? | **EXTERIOR WALL** - LOADBEARING NON-FIRE RATED STC (N/A) SIM. TO GA NO. (N/A)

W6EL | EXTERIOR - LAPPED SIDING W6EM1 | EXTERIOR - METAL SIDING - COLOR 1 W6EM2 | EXTERIOR - METAL SIDING - COLOR 2 W6EM3 EXTERIOR - METAL SIDING - COLOR 3

SEE ELEVATIONS FOR

SIDING INFO

5 1/2" 5/8" 5/8" GWB EA SIDE 2x6 WOOD STUDS AT 16" O.C.

> INTERIOR WALL - NON-LOADBEARING NON-FIRE RATED - SIM. TO GA NO. WP N/A

W61 | SIMILAR TO TYPE "W6" GYP BOARD ON ONE SIDE ONLY

W6S | SIMILAR TO TYPE "W6"

ADD SOUND BATT INSULATION

5/8" 3 1/2" 5/8" 5/8" GWB EA SIDE 2x4 WOOD STUDS AT 16" O.C.

> INTERIOR WALL - NON-LOADBEARING NON-FIRE RATED

- SIM. TO GA NO. WP N/A SIMILAR TO TYPE "W4" GYP BOARD ON ONE SIDE ONLY

W4S | SIMILAR TO TYPE "W4"

ADD SOUND BATT INSULATION

| W41S | SIMILAR TO TYPE "W4" GYP BOARD ON ONE SIDE ONLY ADD SOUND BATT INSULATION

GENERAL WALL NOTES:

1. CONTRACTOR HAS THE OPTION TO USE WOOD OR METAL STUDS. 2. ALL WALLS SHALL BE TAPED, SANDED AND READY FOR PAINT UNLESS NOTED OTHERWISE.

FASTENING (NON-FIRE-RESISTANCE RATED WALLS) A. FASTEN STUDS TOP AND BOTTOM TO RESIST 5 PSF LATERAL

B. FOR METAL STUDS:

a. FOR 16" O.C. STUD SPACING

• SECURE GYP BD WITH 1" (MINIMUM - 1-1/4" PREFERRED) TYPE 'S-12' DRYWALL SCREWS AT 16" O.C.

 ATTACH STUDS TO TOP/BOTTOM PLATES WITH 1/2" TYPE 'S-12' PAN HEAD SCREWS

 ATTACH 3/8" MINIMUM FROM EDNS AND EDGES OF PANELS

b. FOR 24" O.C. STUD SPACING

 SECURE GYP BD WITH 1" (MINIMUM - 1-1/4" PREFERRED) TYPE 'S-12' DRYWALL SCREWS AT 12" O.C.

 ATTACH STUDS TO TOP/BOTTOM PLATES WITH 1/2" TYPE 'S-12' PAN HEAD SCREWS

 ATTACH 3/8" MINIMUM FROM EDNS AND EDGES OF PANELS

c. STAGGER GYP BD JOINTS ON OPPOSITE SIDES

C. FOR WOOD STUDS:

a. FOR 16" O.C. STUD SPACING

 SECURE GYP BD WITH 1" (MINIMUM - 1-1/4" PREFERRED) TYPE 'W' DRYWALL SCREWS AT 16" O.C.:

 12" O.C. AT TOP/BOTTOM PLATES AND INTERMEDIATE STUDS.

• 3/8" MINIMUM FROM ENDS AND EDGES OF PANELS. b. STAGGER GYP BD JOINTS 24" ON OPPOSITE SIDES

4. USE MOISTURE-RESISTANT GYP BD AT ALL WET AREAS

TYPICAL WALL TYPE DESIGNATION:

WALL TYPE TAG: | 1W4A1 | ---FIRE RATING (IF PRESENT) **CORE MATERIAL** CORE WIDTH ASSEMBLY TYPE (IF PRESENT)

ASSEMBLY MODIFIER (IF PRESENT)

12 = 12" CONC

14 = 14" CONC

FIRE RATING: 1 = 1 HOUR 2 = 2 HOUR

CORE MATERIAL W = WOOD STUD S = STEEL STUD M = MASONRY (CMU) C = CONCRETE P = PEMB

CORE WIDTH EXAMPLES: ASSEMBLY TYPE: SEE WALL TYPES 2 = 1-1/2" STUD FURRING 4 = 2X4 OR 3-5/8" STEEL STUD SHEET FOR 6 = 2X6 OR 6" STEEL STUD ASSEMBLY INFO

<u> ASSEMBLY MODIFIER EXAMPLES:</u> 1 = FINISH ON 1 SIDE ONLY (FURRING) S = SOUND BATT INSULATION

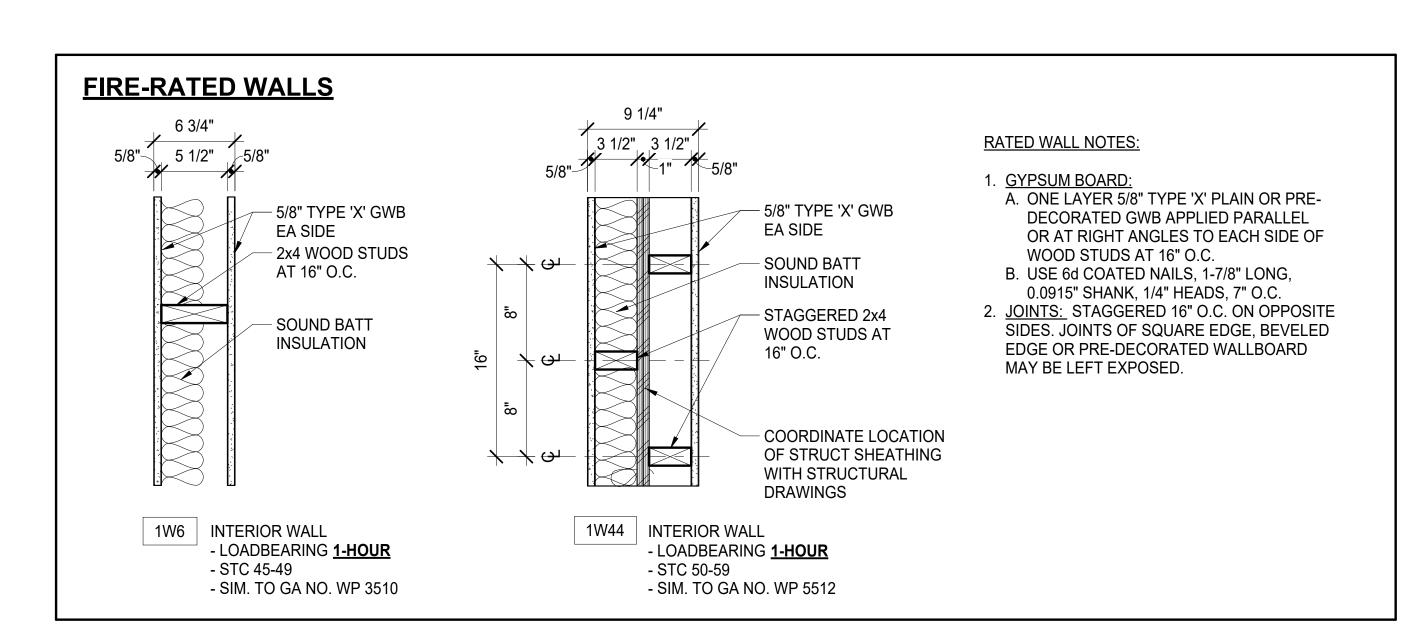
W = ADD WAINSCOT

Wall Type Designation

8 = 8" CONC, CMU OR 8" GIRTS

NOTE: WALL SCHEDULE PROVIDED AS A CONVEINIENCE ONLY AND SHALL NOT BE USED FOR MATERIAL TAKEOFFS, ESTIMATING OR ORDERING OF MATERIAL.

Wall Schedule Count Type Mark Type Mark Type Fire Rating | Core Width | Length I-W44R - 2x4" DBL Wd Stud, 5/8" Gyp Bd - TYPE 1 HOUR 3 1/2" 108 LF 1W44 1W44 I-W4 - 2x4" Wd Stud, 5/8" Gyp Bd - TYPE W4 3 1/2" 531 LF 77 W4 W4S I-W4S - 2x4" Wd Stud, 5/8" Gyp Bd SOUND - TYPE 131 LF 12 W4S 3 1/2" IF-W4 - 2x4 Wd Stud, 5/8" Gyp Bd ONE SIDE -3 1/2" 74 LF W41 TYPE W41 W41S | IF-W4 - 2x4 Wd Stud, 5/8" Gyp Bd ONE SIDE 3 1/2" 16 LF W41S SOUND - TYPE W41S I-W6R - 2x6 Wd Stud, 5/8" Gyp Bd - 1 HOUR -1 HOUR 5 1/2" 35 LF 1W6 TYPE 1W6 I-W6 - 2x6" Wd Stud, 5/8" Gyp Bd - TYPE W6 5 1/2" 120 LF 10 W6 W6EL E-W6 - 2X6 Wd Stud, Sheathing, LAP Siding -W6EL 5 1/2" 68 LF TYPE W6EL W6EM1 E-W6 - 2X6 Wd Stud, Sheathing, METAL Siding -5 1/2" W6EM1 60 LF TYPE W6EM1 W6EM2 <varies> 5 1/2" W6EM2 252 LF 19 I-W6S - 2x6" Wd Stud, 5/8" Gyp Bd SOUND - TYPE 94 LF 12 W6S 5 1/2" IF-W6 - 2x6 Wd Stud, 5/8" Gyp Bd ONE SIDE -5 1/2" 14 LF TYPE W61 IF-W8 - 2x8 Wd Stud, 1/2" Plywd ONE SIDE - TYPE 5 1/2" W81 64 LF E-C8 - 8" Conc - TYPE C8 8" 131 LF 10 C8 C8AA E-C8 - 8" Conc, 3.5" Furring BOTH SIDES - TYPE 65 LF C8B E-C8 - 8" Concrete, 3.5" Furring - TYPE C8B 8" 269 LF 22 C8B 2,031 LF 212



Wall Types 1 1/2" = 1'-0"

A6.1B DRAWINGS AT 11x17 ARE 1/2 SCALE INDICATED

FNA Project #: 2024_60A Project Start Date: 11-06-2024

Release Date: 03-27-2025 Released for: Issued for Bid/ Permit/ Construction

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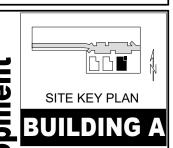
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PROFESSION



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Baxter Residential Multi-Family - 6 Plex CIHA - E
Phase 1 - N
BUILDING /
Tract B
Valetskaya Addition
4220 Baxter Roan
Anchung

Sheet name
Wall Types

sheet number

						Doo	r Schedi	ule				
	Roo	om	Operatio	Si	Size Ma		erial			Sill		
Mark	From	То	n / Type	Width	Height	Door	Frame	Glazing	Fire Rating	Height	Comments	Mark
3asem	ent											
B01	GIIL	B-01	SH	4' - 0"	6' - 8"	HC-WD	MTL	-	_	0"		B01
B02	B-01	B-02	SH	3' - 0"	6' - 8"	SC-WD	WD	_	_	0"		B02
B03	D 01	B-03	SH	3' - 0"	6' - 8"	SC-WD	WD	_	_	0"		B03
B04	B-01	B-04	SH	4' - 0"	6' - 8"	HC-WD	MTL	_	_	0"		B04
B05	B-01	B-05	SH	3' - 0"	6' - 8"	SC-WD	WD	-	_	0"		B05
B06	B-01	B-06	SH	3' - 0"	6' - 8"	SC-WD	WD	-	_	0"		B06
B07	B-04	B-07	OP	3' - 0"	6' - 8"	-	WD	-	_	0"		B07
B08	B-08	B-04	SH	3' - 0"	6' - 8"	SC-WD	WD	-	-	0"		B08
D00	D-00	D-04	011	3 - 0	0-0	30-110	VVD	_		0		
1st Floo	or											
10A		A10-01	SH	3' - 0"	6' - 8"	SC-WD	WD	-	20 Minute	0"		10A
100A		A100-02	SH2L	3' - 0"	6' - 8"	SC-WD	WD	Half	-	0"		100A
100B		A100-02	SH	3' - 0"	6' - 8"	SC-WD	WD	-	-	0"		100B
100C	A100-02	A100-02	OP	3' - 0"	6' - 8"	-	WD	-	-	0"		1000
100D	A100-02	A100-03	SH	3' - 0"	6' - 8"	SC-WD	WD	-	-	0"		1000
101A		A101-07	SH	3' - 0"	6' - 8"	SC-WD	WD	-	20 Minute	0"		101A
101B	A101-01	A101-07	SH	3' - 0"	6' - 8"	SC-WD	WD	-	-	0"		101E
101C		A101-07	SH	2' - 6"	6' - 8"	HC-WD	WD	_		0"		101C
101D		A101-02	SH	2' - 6"	6' - 8"	HC-WD	WD	_		0"		1010
101E	A101-07		SH	3' - 0"	6' - 8"	SC-WD	WD	_	_	0"		101E
101F	71101 07	A101-07	SH	2' - 0"	6' - 8"	HC-WD	WD	-		0"		101F
101G		A101-04	P	6' - 0"	6' - 8"	ALUM	ALUM	Full	_	0"		1010
101H	A101-05	71101 01	DS	4' - 0"	6' - 8"	SC-WD	WD	-	_	0"		101H
101J	A101-07	A101-05	SH	3' - 0"	6' - 8"	SC-WD	WD	_	_	0"		101J
101K	A101-07	A101-06	SH	3' - 0"	6' - 8"	SC-WD	WD			0"		1013 101K
101L	A101-01	A101-06	DS	4' - 0"	6' - 8"	SC-WD	WD	-	<u>-</u>	0"		101L
101L		A101-08	SH	3' - 0"	6' - 8"	SC-WD	WD		20 Minute	0"		101L
102A 102B	A102-01	A102-08	SH	2' - 6"	6' - 8"	HC-WD	WD	-	20 Millate	0"		102A
	A102-01		DS	5' - 0"	6' - 8"	SC-WD	WD	-	-	0"		1026
102C	A 102 00	A102-02						-	-	0"		
102D	A102-08	A102-02	SH	3' - 0"	6' - 8"	SC-WD	WD	-	-			102D
102E	A 4 0 2 0 0	A102-03	SH	2' - 4"	6' - 8"	HC-WD	WD	-		0"		102E
102F	A102-08	A102-03	SH	3' - 0"	6' - 8"	SC-WD	WD	-	-	0"		102F
102G	A102-06	A102-04	SH	3' - 0"	6' - 8"	SC-WD	WD	-	-	0"		102G
102H		A102-04	DS	5' - 0"	6' - 8"	SC-WD	WD	-	-	0"		102H
102J	A 4 0 0 0 0	A102-05	DS	5' - 0"	6' - 8"	SC-WD	WD	-	-	0"		102J
102K	A102-06	A102-05	SH	3' - 0"	6' - 8"	SC-WD	WD	-	-	0"		102K
102L		A102-06	Р	6' - 0"	6' - 8"	ALUM	ALUM	Full	-	0"		102L
102M		A102-08	SH	2' - 0"	6' - 8"	HC-WD	WD	-		0"		102N
102N		A102-08	OP	5' - 0"	6' - 8"	-	WD	-	-	0"		102N
102P		A102-08	DS	4' - 0"	6' - 8"	SC-WD	WD	-	-	0"		102F
103A		A103-07	SH	3' - 0"	6' - 8"	SC-WD	WD	-	20 Minute	0"		103A
103B		A103-01	DS	5' - 0"	6' - 8"	SC-WD	WD	-	-	0"		103B
103C	A103-07	A103-01	SH	3' - 0"	6' - 8"	SC-WD	WD	-	-	0"		103C
103D	A103-07	A103-02	SH	3' - 0"	6' - 8"	SC-WD	WD	-	-	0"		103D
103E		A103-02	DS	5' - 0"	6' - 8"	SC-WD	WD	-	-	0"		103E
103F		A103-03		6' - 0"	6' - 8"	ALUM	ALUM	Full	-	0"		103F
103G		A103-04	SH	2' - 0"	6' - 8"	HC-WD	WD	-		0"		1030
103H	A103-07	A103-05	SH	3' - 0"	6' - 8"	SC-WD	WD	-	-	0"		103F
103J	A103-05	A103-05	SH	2' - 6"	6' - 8"	HC-WD	WD	-		0"		103J
103K	A103-06	A103-07	SH	3' - 0"	6' - 8"	SC-WD	WD	-	-	0"		103k
103L		A103-07	SH	2' - 6"	6' - 8"	HC-WD	WD	-		0"		103L
20214	A 4 0 0 0 0	A400 00	CLI	21 0"	C! O!!	CC MD	WD		20 Minute	O"		20214

	SEE P	PLANS AND ELEVATIONS FOR LEFT / RIG	HT ASPECT	
		FIXED <	OPEN	> <
TYPE SH	TYPE SH2L	TYPE P	TYPE OP	TYPE DS
- SINGLE - HINGED	- SINGLE - HINGED - HALF LITE	- "PATIO" DOOR - 1 SLIDING PANEL - 1 FIXED PANEL - FULL-GLAZED	- CASED OPENING - NO DOOR	- DOUBLE - BY-PASS SLIDER

WD

20 Minute

	Door Schedule											
	Ro	om	Operatio	Si	Size	Material				Sill		
Mark	From	То	n / Type	Width	Height	Door	Frame	Glazing	Fire Rating	Height	Comments	Mark
2nd Flo	or											
20A		A20-01	SH	3' - 0"	6' - 8"	SC-WD	WD	_	20 Minute	0"		20A
201A		A201-07	SH	3' - 0"	6' - 8"	SC-WD	WD	_	20 Minute	0"		201A
201B	A201-01	A201-07	SH	3' - 0"	6' - 8"	SC-WD	WD	_	-	0"		201B
201C	7.20.0.	A201-07	SH	2' - 6"	6' - 8"	HC-WD	WD	_		0"		2010
201D		A201-02	SH	2' - 6"	6' - 8"	HC-WD	WD	-		0"		2010
201E	A201-07	A201-02	SH	3' - 0"	6' - 8"	SC-WD	WD	_	_	0"		201E
201F		A201-07	SH	2' - 0"	6' - 8"	HC-WD	WD	_		0"		201F
201G		A201-04	Р	6' - 0"	6' - 8"	ALUM	ALUM	Full	-	0"		201G
201H	A201-05		DS	4' - 0"	6' - 8"	SC-WD	WD	-	-	0"		201H
201J	A201-07	A201-05	SH	3' - 0"	6' - 8"	SC-WD	WD	-	-	0"		201J
201K	A201-07	A201-06	SH	3' - 0"	6' - 8"	SC-WD	WD	-	-	0"		201K
201L		A201-06	DS	4' - 0"	6' - 8"	SC-WD	WD	-	-	0"		201L
202A		A202-08	SH	3' - 0"	6' - 8"	SC-WD	WD	-	20 Minute	0"		202A
202B	A202-01	A202-08	SH	2' - 6"	6' - 8"	HC-WD	WD	-	-	0"		202B
202C		A202-02	DS	5' - 0"	6' - 8"	SC-WD	WD	-	-	0"		202C
202D	A202-08	A202-02	SH	3' - 0"	6' - 8"	SC-WD	WD	-	-	0"		202D
202E		A202-03	SH	2' - 4"	6' - 8"	HC-WD	WD	-		0"		202E
202F	A202-08	A202-03	SH	3' - 0"	6' - 8"	SC-WD	WD	-	-	0"		202F
202G	A202-06	A202-04	SH	3' - 0"	6' - 8"	SC-WD	WD	-	-	0"		202G
202H		A202-04	DS	5' - 0"	6' - 8"	SC-WD	WD	-	-	0"		202H
202J		A202-05	DS	5' - 0"	6' - 8"	SC-WD	WD	-	-	0"		202J
202K	A202-06	A202-05	SH	3' - 0"	6' - 8"	SC-WD	WD	-	-	0"		202K
202L		A202-06	Р	6' - 0"	6' - 8"	ALUM	ALUM	Full	-	0"		202L
202M		A202-08	SH	2' - 0"	6' - 8"	HC-WD	WD	-		0"		202N
202N		A202-08	OP	5' - 0"	6' - 8"	-	WD	-	-	0"		202N
202P		A202-08	DS	4' - 0"	6' - 8"	SC-WD	WD	-	-	0"		202P
203A		A203-07	SH	3' - 0"	6' - 8"	SC-WD	WD	-	20 Minute	0"		203A
203B		A203-01	DS	5' - 0"	6' - 8"	SC-WD	WD	-	-	0"		203B
203C	A203-07	A203-01	SH	3' - 0"	6' - 8"	SC-WD	WD	-	-	0"		203C
203D	A203-07	A203-02	SH	3' - 0"	6' - 8"	SC-WD	WD	-	-	0"		203D
203E		A203-02	DS	5' - 0"	6' - 8"	SC-WD	WD	-	-	0"		203E
203F		A203-03	Р	6' - 0"	6' - 8"	ALUM	ALUM	Full	-	0"		203F
203G		A203-04	SH	2' - 0"	6' - 8"	HC-WD	WD	-		0"		203G
203H	A203-07	A203-05	SH	3' - 0"	6' - 8"	SC-WD	WD	-	-	0"		203H
203J	A203-05		SH	2' - 6"	6' - 8"	HC-WD	WD	-		0"		203J
203K	A203-06	A203-07	SH	3' - 0"	6' - 8"	SC-WD	WD	-	-	0"		203K
203L		A203-07	SH	2' - 6"	6' - 8"	HC-WD	WD	-		0"		203L

HARDWARE NOTES:

303M

- 1. ALL LOCKSETS SHALL HAVE LIPS OF SUFFICIENT LENGTH TO CLEAR TRIM AND PROTECT CLOTHING.
- 2. GENERAL CONTRACTOR TO COORDINATE HARDWARE PURCHASE, SPECIFICATION, AND INSTALLATION WITH BUILDING MANAGEMENT AND/OR OWNER.
- 3. KEYING OF CYLINDER LOCKS SHALL BE COORDINATED WITH THE OWNER. UNDER OWNER'S DIRECTION, KEY TO NEW OR EXISTING SYSTEM TO BE APPROVED BY OWNER'S REPRESENTATIVE IN WRITING. FURNISH CONSTRUCTION KEY SYSTEM WITH KEYS WHICH CAN BE RENDERED INOPERATIVE BY THE TURN OF THE CHANGE KEY. STAMP ALL KEYS "DO NOT DUPLICATE".
- 4. FURNISH THREE HINGES PER LEAF MIN, U.N.O. FURNISH HINGES WITH STAINLESS STEEL PINS AND CONCEALED BEARINGS.
- 5. FURNISH SILENCERS FOR ALL INTERIOR FRAMES: 3 FOR SINGLE DOORS, 4 FOR PAIR OF DOORS. OMIT WHERE SOUND OR LIGHT SEAL OCCURS.
- 6. INSTALL EACH HARDWARE ITEM PER MANUFACTURER'S INSTRUCTIONS AND RECOMMENDATIONS. DO NOT INSTALL SURFACE-MOUNTED ITEMS UNTIL FINISHES HAVE BEEN COMPLETED ON THE SUBSTRATE. SET UNITS LEVEL, PLUMB, AND TRUE TO LINE AND LOCATION. ADJUST AND REINFORCE THE ATTACHMENT SUBSTRATE AS NECESSARY FOR PROPER INSTALLATION AND OPERATION. ADJUST AND CHECK EACH OPERATING ITEM OF HARDWARE AND EACH DOOR TO ENSURE PROPER OPERATION OR FUNCTION OF EVERY UNIT. REPLACE UNITS WHICH CANNOT BE ADJUSTED TO OPERATE FREELY AND SMOOTHLY.
- 7. ALL ELECTRONIC HARDWARE SHALL BE FAILSAFE AND TIED INTO THE LIFE-SAFETY SYSTEM.
- 8. ALL EXIT DOORS SCHEDULED WITH ELECTRONIC HARDWARE SHALL UNLOCK UPON THE ACTUATION OF A LIFE-SAFETY DEVICE. ALL DOORS REQUIRED AS EXITS WITH ELECTRONIC HARDWARE UNLOCK UPON THE LOSS OF POWER CONTROLLING THE LOCK OR LOCK MECHANISM. ALL DOORS REQUIRED AS EXITS WITH ELECTRONIC HARDWARE SHALL HAVE THE CAPABILITY OF BEING UNLOCKED BY A SIGNAL FROM THE FIRE COMMAND CENTER IN HIGHRISE BUILDINGS WHERE
- 9. EMERGENCY LIGHTING AND AUDIBLE ALARM SHALL BE PROVIDED AT ALL DOORS REQUIRED AS EXITS WITH DELAYED EGRESS ELECTRIC HARDWARE. ALARM SHALL NOTIFY TENANT FLOOR AND CUSTOMER'S BURGLAR ALARM SYSTEM.
- 10. ALL DOORS WITH LOCK SETS AND LATCH SETS SHALL HAVE A LEVER HANDLE. 11. HAND-ACTIVATED DOOR OPENING HARDWARE MUST BE MOUNTED BETWEEN 34 AND 48 INCHES ABOVE FINISH FLOOR.
- 12. DOOR HARDWARE SHALL BE OPERABLE WITH A SINGLE EFFORT WITHOUT REQUIRING THE ABILITY TO GRASP THE HARDWARE (LEVER OR PUSH TYPE IS ACCEPTABLE PER LOCAL JURISDICTION CODE-DEFINED CRITERIA)
- 13. CARD READER DEVICES TO BE PROVIDED AS REFERENCED IN DOOR SCHEDULE. ALL DEVICES AND INSTALLATION SHALL COMPLY WITH ALL APPLICABLE BUILDING CODES.

DOOR HARDWARE GROUPS								
HARDWARE	ARDWARE LOCK LOCATION LEVER / PULL							
GROUP	FUNCTION		MODEL	FINISH				
1	ENTRY	UNIT OR OFFICE ENTRY, BASEMENT	SCHLAGE ND53PD-RHO RHODES ENTRANCE	SATIN NICKEL (619)				
		(EXCEPT CRAWLSPACE ACCESS),	DOOR LEVER SET					
		STORAGE ROOM						
2	PRIVACY	BATH / TOILET ROOMS	SCHLAGE ND40S-RHO RHODES PRIVACY	SATIN NICKEL (619)				
			DOOR LEVER SET					
3	PASSAGE	ALL INTERIOR HINGED-DOORS OTHER	SCHLAGE ND10S-RHO RHODES PASSAGE	SATIN NICKEL (619)				
		THAN GROUPS 1 & 2	DOOR LEVER SET					

GENERAL DOOR NOTES:

- 1. SEE CODE STUDY FOR ADDITIONAL DOOR HARDWARE NOTES AND REQUIREMENTS. IF THERE IS A DISCREPANCY BETWEEN THE CODE STUDY AND THE DOOR SCHEDULE NOTIFY ARCHITECT.
- 2. ALL DOORS SHALL BE ARRANGED TO BE OPENED FROM THE EGRESS SIDE WITHOUT A KEY OR SPECIAL KNOWLEDGE OR EFFORT.
- 3. ALL DOORS SHALL HAVE LEVER-OPERATED MECHANISMS UNLESS ENTRY DOOR WHICH RECEIVES EXTERIOR PULL AND INTERIOR PUSH BAR.
- 4. PROVIDE MIN 3 HINGES PER DOOR. 5. ALL DOORS TO BE PLACED 4 INCHES FROM ADJACENT WALL UNLESS NOTED OTHERWISE.
- 6. ALL DOOR HARDWARE SHALL MEET ADA REQUIREMENTS.
- 7. ALL DOOR GLAZING TO BE TEMPERED
- 8. ALL EXTERIOR DOORS TO BE INSULATED AND HAVE WEATHERSTRIPPING. THERMAL BREAK THRESHOLD AND SWEEP.
- 9. SEE PLAN FOR DOOR OPERATION (SWING/SLIDE) DIRECTION (LEFT / RIGHT)
- 10. EXTERIOR LANDING MAY SLOPE UP TO 1/4" PER FOOT (MAX) IN ANY DIRECTION FOR SURFACE DRAINAGE.
- 11. THE FLOOR OR LANDING SHALL NOT BE MORE THAN 1/2" LOWER THAN THE THRESHOLD OF THE DOORWAY. BEVEL (1:2 MAX. SLOPE) WHERE THE THRESHOLD EXCEEDS 1/4" IN HEIGHT.
- 12. DOORS OPENING INTO REQUIRED EXIT CORRIDORS MAY NOT RESTRICT THE REQUIRED WIDTH WHEN OPENED IN ANY POSITION.
- 13. ALL DOORS REQUIRED AS EXITS SHALL SWING IN THE DIRECTION OF TRAVEL.
- 14. FIRE RATED DOOR SHALL HAVE RATING LABEL VISIBLE
- 15. TRIM THE BOTTOMS OF DOORS TO CLEAR THE TOP OF FINISHED FLOOR, AS APPLICABLE, BY 1/4" INCH MAXIMUM, U.N.O. VERIFY SLAB CONDITIONS AND TRIM EACH DOOR TO FIT CONDITIONS. WHERE RADICAL VARIATIONS IN FLOOR ELEVATION EXIST, DOORS SHALL BE ORDERED WITH BOTTOM STILE SIZED TO ACCOMMODATE THESE UNDERCUT CONDITIONS.

STOREFRONT DOOR NOTES:

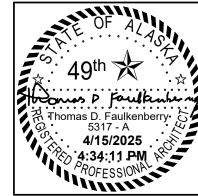
- 1. ALL HINGED ALUMINUM STOREFRONT DOORS SHALL HAVE CONTINUOUS
- 2. STOREFRONT SUPPLIER SHOULD PROVIDE ALL DOOR HARDWARE INCLUDING CLOSERS, CYLINDERS, PUSH / PULLS AND ECONOMY EXIT DEVICES.
- 3. STOREFRONT TO MEET MOA MINIMUM REQUIREMENTS. ENGINEERING TO MEET MOA DEFERRED SUBMITTAL TO BE PROVIDED BY STOREFRONT CONTRACTOR IF REQUIRED.

FNA Project #: 2024_60A Project Start Date: 11-06-2024

Release Date: 03-27-2025

Released for: Issued for Bid/ Permit Construction

04-15-2025 Address Bidder Questions









sidential 6 Plex **4 Baxter Re**Multi-Family

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CIHA - Bhase 1 - BUILDING
Tract B Valetskaya Adv

S Door/ Hardware

∑ Schedule Sheet number

│303M│A102-08│A102-09│ SH │3' - 0"│6' - 8"│ SC-WD

	DECCRIPTION	RAALI IFACTURER	-	1	PECIALTY EQUIPMENT
MARK	DESCRIPTION	MANUFACTURER	MODEL	FINISH	COMMENTS
BUILDIN	IG EQUIPMENT				
MB3	MAILBOXES	FLORENCE CORP	VITAL CBU 1570-8T6-	POSTAL GREY	PEDESTAL MOUNT ADA HEIGHT MAILBOXES, 8 TENANT DOORS, 4 PARCEL BOXES, 1
			PG		OUTGOING, PROVIDE (3) KEYS, (1) CLEAR PLASTIC CARD HOLDER PER BOX, FRONT
					LOAD UNITS, USPS ACCESS, ADA COMPLIANT
INIIT AE	DDIIANCES (ALL LINUTS)				
)1	PPLIANCES (ALL UNITS) DRYER	GE APPLIANCES	GFD55ESSNWW	WHITE	FRONT LOAD ELECTRIC DRYER WITH CONTROLS ON FRONT, 7.8 CU FT CAPACITY, ADA
_					COMPLIANT
DW1	DISHWASHER	GE APPLIANCES	GDTT225SGLWW	WHITE	24" WIDE DISHWASHER WITH FRONT CONTROLS AND POWER CORD, ENERGY STAR
					QUALIFIED, QUIET PACKAGE, ADA COMPLIANT
REF1	REFRIGERATOR	GE APPLIANCES	GSE23GGPWW	WHITE	23 CU FT, SIDE BY SIDE REFRIGERATOR WITH ICE MAKER, ENERGY STAR QUALIFIED,
 RH1	RANGE HOOD	PER MECHANICAL	PER MECHANICAL	WHITE	UFAS COMPLIANT 30" UNDER CABINET HOOD, REFER TO INTERIOR ELEVATIONS FOR UFAS COMPLIANT
VI I T	MANUE HOOD	LI WILCHAINICAL	I LI WILCHAMICAL	VVIIII	SWITCH AT UFAS UNITS
W1	WASHER	GE APPLIANCES	GFW510SCNWW	WHITE	FRONT LOAD ENERGY STAR QUALIFIED, 4.5 CU FT CAPACITY, ADA COMPLIANT
JNIT AF	PPLIANCES (NON-UFAS)				
RG1	RANGE	GE APPLIANCES	JB258DMWW	WHITE	30" FREE-STANDING, SELF-CLEANING ELECTRIC RANGE, ELECTRIC COILS
			•	•	·
	PPLIANCES (UFAS)				
RG2	DROP-IN RANGE	GE APPLIANCES	JDO630DFWW	WHITE	ENERGY STAR QUALIFIED 30" DROP-IN ELECTRIC RANGE, CERAMIC GLASS COOKTOP,
	(UFAS)				ELECTRIC OVEN WITH GLASS DOOR FRONT, ADA COMPLIANT
UNIT RA	ATH TOILET ACCESSORI	FS			
BTS	BATHTUB SEAT (UFAS)		FOLDING TUB SEAT	WHITE	
	,				
GB	GRAB BARS (UFAS)	BOBRICK	B-6806 SERIES	SATIN-FINISH	
				STAINLESS STEEL	
MR1	MIRROR	-	44X36 POLISHED	SATIN NICKEL	MOUNT TO WALL WITH MASTIC AND ALUMINUM J-MOLD AT TOP AND BOTTOM
MD2	MIDDOD		EDGES	CATINI NUCKEI	NACHNIT TO MALL MAITH MACTIC AND ALLINABILINA I NACHD AT TOD AND DOTTORA
MR2	MIRROR	-	36X36 POLISHED EDGES	SATIN NICKEL	MOUNT TO WALL WITH MASTIC AND ALUMINUM J-MOLD AT TOP AND BOTTOM
SCR	SHOWER CURTAIN	BOBRICK	B-207	SATIN-FINISH	HEAVY DUTY, COORDINATE EXACT LOCATION WITH OWNER PRIOR TO INSTALLATION
	ROD		5 207	STAINLESS STEEL	
SGB	SHOWER GRAB BARS	BOBRICK	B-6806 SERIES	SATIN-FINISH	
				STAINLESS STEEL	
ГН	TOWEL HOOK	MOEN / METHOD	YB2403CH	SATIN NICKEL	
ΓPD1	TOILET PAPER	MOEN / METHOD	YB2408CH	SATIN NICKEL	
	DISPENSER				
TR	TOWEL RING	MOEN / METHOD	YB2486CH	SATIN NICKEL	
INIT EI	ECTRICAL				
OP	DATA PANEL	REFER TO ELECTRICAL			
EP	ELECTRICAL PANEL	REFER TO ELECTRICAL			
M TINU	ISCELLANEOUS			1	
CH	COAT HOOKS	BRADLEY CORP	9134 HAT & COAT	SATIN-FINISH	
			HOOK	STAINLESS STEEL	

APPLIANCE GENERAL NOTES

1. SIDE BY SIDE WASHER / DRYER INSTALLATION. WASHER ON LEFT, DRYER ON RIGHT IN ALL UNITS. WASHER DOOR TO HINGE ON LEFT

SIDE, DRYER DOOR TO HINGE ON RIGHT SIDE.

2. CONTRACTOR TO TEST RUN ALL APPLIANCES AFTER INSTALLATION.

FINISHES / MATERIALS / COLORS							
AREA / OBJECT	MANUFACTURER	MODEL / MATERIAL	COLOR / FINISH				
FLOORING	TAS LVP	EXPEDITION	COLOR: T.B.D.				
CABINETRY	SMART CABINETRY	DOOR: FREEPORT	COLOR: T.B.D.				
PAINT	SHERWIN WILLIAMS		COLOR: WHISPER WHITE				
			WALLS: EGGSHELL				
			TRIM: ENAMEL				
			CEILINGS: FLAT				
SOLID SURFACE	HI-MACS	2024 ALL-STAR PROGRAM GROUP B	COLOR: T.B.D.				
TRIM		MDF	DOORS 1" X 2"				
			BASE 1" X 3"				

MATERIAL GENERAL NOTES

1. WALL / CEILING PAINT AND TEXTURE:

A. TEXTURE: LIGHT ORANGE PEEL

B. FIRST COAT: SHERWIN WILLIAMS PVA DRYWALL PRIMER AND SEALER C. SECOND COAT: PRODUCT AS SPECIFIED IN COLOR AND MATERIAL SCHEDULE

D. THIRD COAT: PRODUCT AS SPECIFIED IN COLOR AND MATERIAL SCHEDULE

2. MILLWORK PAINT AND TEXTURE:

A. FIRST COAT: SHERWIN WILLIAMS MULTI-PURPOSE OIL-BASED PRIMER B. SECOND COAT: PRODUCT AS SPECIFIED IN COLOR AND MATERIAL SCHEDULE

C. THIRD COAT: PRODUCT AS SPECIFIED IN COLOR AND MATERIAL SCHEDULE

FINISH NOTES

1. FLOORING: LVP (THROUGHOUT)

2. BASE:

A. DRY AREAS: WOOD

B. WET AREAS: RUBBER

3. PAINT:

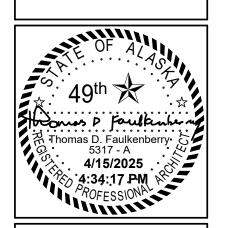
A. ALL WALLS

B. ALL HARD LIDS

FNA Project #: 2024_60A Project Start Date:

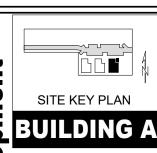
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A - Baxter Residential Development
e 1 - Multi-Family - 6 Plex

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sya Addition # 1Subdivision

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syar Addition # 1Subdivision

Sheet name
Appliance and Finish \$ Schedules